Detached Dual Occupancy

For Mr & Mrs Charlton

At Lot 12 DP 851360 198 Wangat Trig Road Bandon Grove NSW 2420

Architectural Drawing Index

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Site Area Schedule

<u>Name</u>	<u>Area</u>	Overall
Impermeable		
Existing Dwelling Footprint	313.1 m ²	0.1%
Existing Shed Footprint	210.0 m ²	0.0%
Proposed Secondary Dwelling Footprint	299.3 m ²	0.1%
Proposed Secondary Shed Footprint	134.1 m²	0.0%
	956.5 m ²	0.2%
Permeable		
Remaining Site	576638.1 m ²	99.8%
	576638.1 m ²	99.8%
Grand site total	577594.6 m ²	100.0%

<u>name</u>	Area
Garage	
Shed	126.2 m ²
	126.2 m²
Ground Floor	
Alfresco	48.0 m ²
Bag/Coat Nook	3.1 m ²
Bathroom	9.5 m ²
Bed 2	14.9 m ²
Bed 3	14.9 m ²
Bed 4 / Office	14.3 m ²
Boot Nook	3.0 m ²
Ensuite	6.0 m ²
Hallway	18.2 m ²
Kitchen	35.4 m ²
Laundry	9.3 m ²
Living	39.0 m ²
Lounge	16.8 m ²
Main Suite	17.1 m ²
Pantry	8.9 m ²
Robe	4.6 m ²
Store	1.3 m ²
WC	6.1 m ²
WIR	7.6 m ²
	278.1 m ²
Grand total	404.3 m ²

- 1. All on site and pre-fabricated workman ship is to be in relavent Australian Standards.
- 2. These drawings shall be read in conjunction with other consultants drawings / specifications and with other such written instructions as may be issued during the construction. Any discrepancy shall be raised with the design office before commencing the work.
- 3. All dimensions are in millimeters, Unless noted otherwise. Site verify all dimensions before ordering Materials. Materials to be ordered are only to be ordered from a Builders or applicable product manufacturers seperate site confirmed Materials list.
- 4. All levels and setting out dimensions shown on the drawings shall be checked on site prior to the commencement of work.

 5. Bracing and tie-down details to the engineers details and
- AS1684.2. 6. All timber and steel to be installed and treated to the manufacturers specifications, especially for any exterior
- applications. 7. All white ant protection to be strictly within the guidelines of AS3660 and installed by a qualified licensed pest control consultant.
- 8. AJ denotes masonary articulation joint, to be installed to AS 3700 section 4.8 requirements.
- 9. All workmanship and materials shall be in accordance with the National Construction Code and relevant Australian

Wind Class: N3 (W41N) (Assumed) Site Class: 'P' Soil Class: 'M'


Site / Soil Class Assumed

Survey Note: Boundary dimensions are assumed only and taken from site information, others or owners

Confirm boundaries before commencement

of construction. Full project specific detailed survey plans have not been supplied to Blencowes Design for planning purposes. See schedule of specifications for details.

Boundary Setback Note: Boundaries are to be pegged and setout confirmed before commencement of construction where proposed works are with

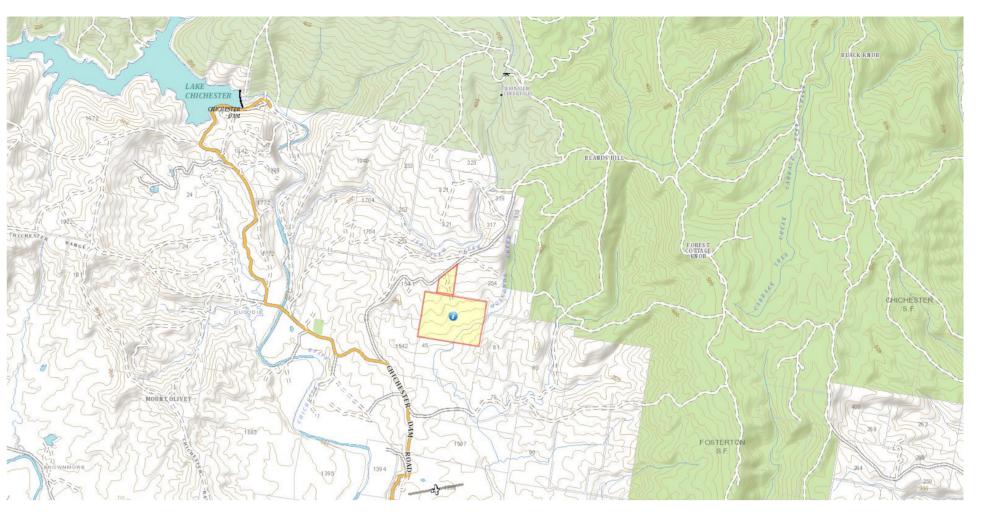

Area Plan



Project Overlay Plan







Client: Mr & Mrs Charlton


Address: Lot 12 DP 851360 198 Wangat Trig Road Bandon Grove NSW 2420

Do not scale off drawings, use shown dimensions only, contact the office if additional dimensions required. Revision Schedule Description 10/02/23 Issued for DA Drawing No: 0121-1208 Sheet:

Scale:



This plans must be provided to any relevant person involved in the demolition and/or construction, including project managers, builders, contractors and sub-contractors as well as being displayed onsite in plain view

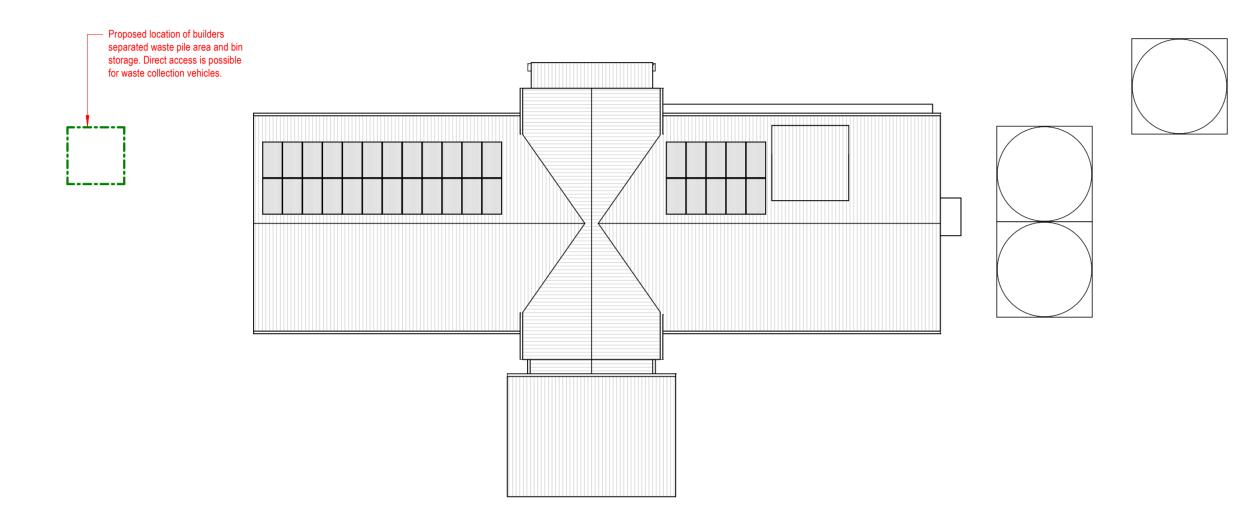

Waste Management Plan

1:200

General Notes

- 1. The main outcome from this plan is to enable maximum diversion of demolition and construction waste to be reused, recycled or composted to reduce building waste going to
- 2. Ensure that waste management is planned across all demolition and construction stages so that reusable resources and waste can be appropriately and effectively stored and removed safely from site without adverse impacts on local amenity.
- 3. Large skip bins are not to be used on site for mixed materials unless they are being sent to a specialised construction waste sorting depot or similar.

Demolition Notes

- 1. To avoid creating demolition waste, wherever practically possible use the existing structure/materials as they are, where they are. If that is not possible re-use them onsite before committing to recycling.
- All demolished materials <u>must be separated</u> into material piles and kept uncontaminated and treated as per the 'Site Waste Minimisation and Management Table' below.

Construction Notes

- 1. To avoid creating additional construction waste, ensure not to over order materials and carefully separate off-cuts to facilitate re-use onsite before setting aside for resale or efficient
- 2. All waste/unwanted construction materials **must be separated** into material piles and kept uncontaminated and treated as per the 'Site Waste Minimisation and Management Table'

Ongoing Waste Management Notes

- 1. A waste cupboard/area in the kitchen will gather daily household waste and consist of 3
- separate bins separating garbage (landfill), recyclable materials and compostable materials. 2. Council's standard garbage, recycling and green waste containers are to be located behind the building line or behind suitable screening that will not impact on adjoining premises and have unobstructed access to Council's usual Collection Point.
- 3. The use of onsite composing and worm farms is highly recommended to produce soil and fertiliser for gardens.
- 4. Council's standard waste pickup is as follows: Garbage (landfill) fortnightly, recycling fortnightly and green waste weekly

Site Waste Minimisation and Management Table								
Type of Material	Reuse and Recycling On-site	Reuse and Recycling Off-site	Disposal					
Excavation Material	Fill, gardens, topsoil	Clean fill site	Unsuitable remainder to Waste Management Facility					
Green Waste	Mulched for gardens, landscaping	Mulched for collection for reuse	Unsuitable remainder to Waste Management Facility					
Bricks	Re-use where possible, crushed for gravel or fill	Concrush	Unsuitable remainder to Waste Management Facility					
Concrete	Re-use where possible, crushed for gravel or fill	Concrush	Unsuitable remainder to Waste Management Facility					
Timber	Reuse where possible eg formwork, packing	Timber recycler	Unsuitable remainder to Waste Management Facility					
Plasterboard	Nil	Nil	Waste Management Facility					
Metals	Reuse where possible	Metal recycler	Unsuitable remainder to Waste Management Facility					
Other - Miscellaneous	Reuse or recycle if possible	Reuse or recycle if possible	Unsuitable remainder to Waste Management Facility					








Revision Schedule Client: Mr & Mrs Charlton 10/02/23 Issued for DA Address: Lot 12 DP 851360 198 Wangat Trig Road Bandon Grove NSW 2420


Do not scale off drawings, contact the office if additional dimensions required. Description Refer to Ar01 for additional notes Drawing No: 0121-1208 Scale: As indicated @ A3

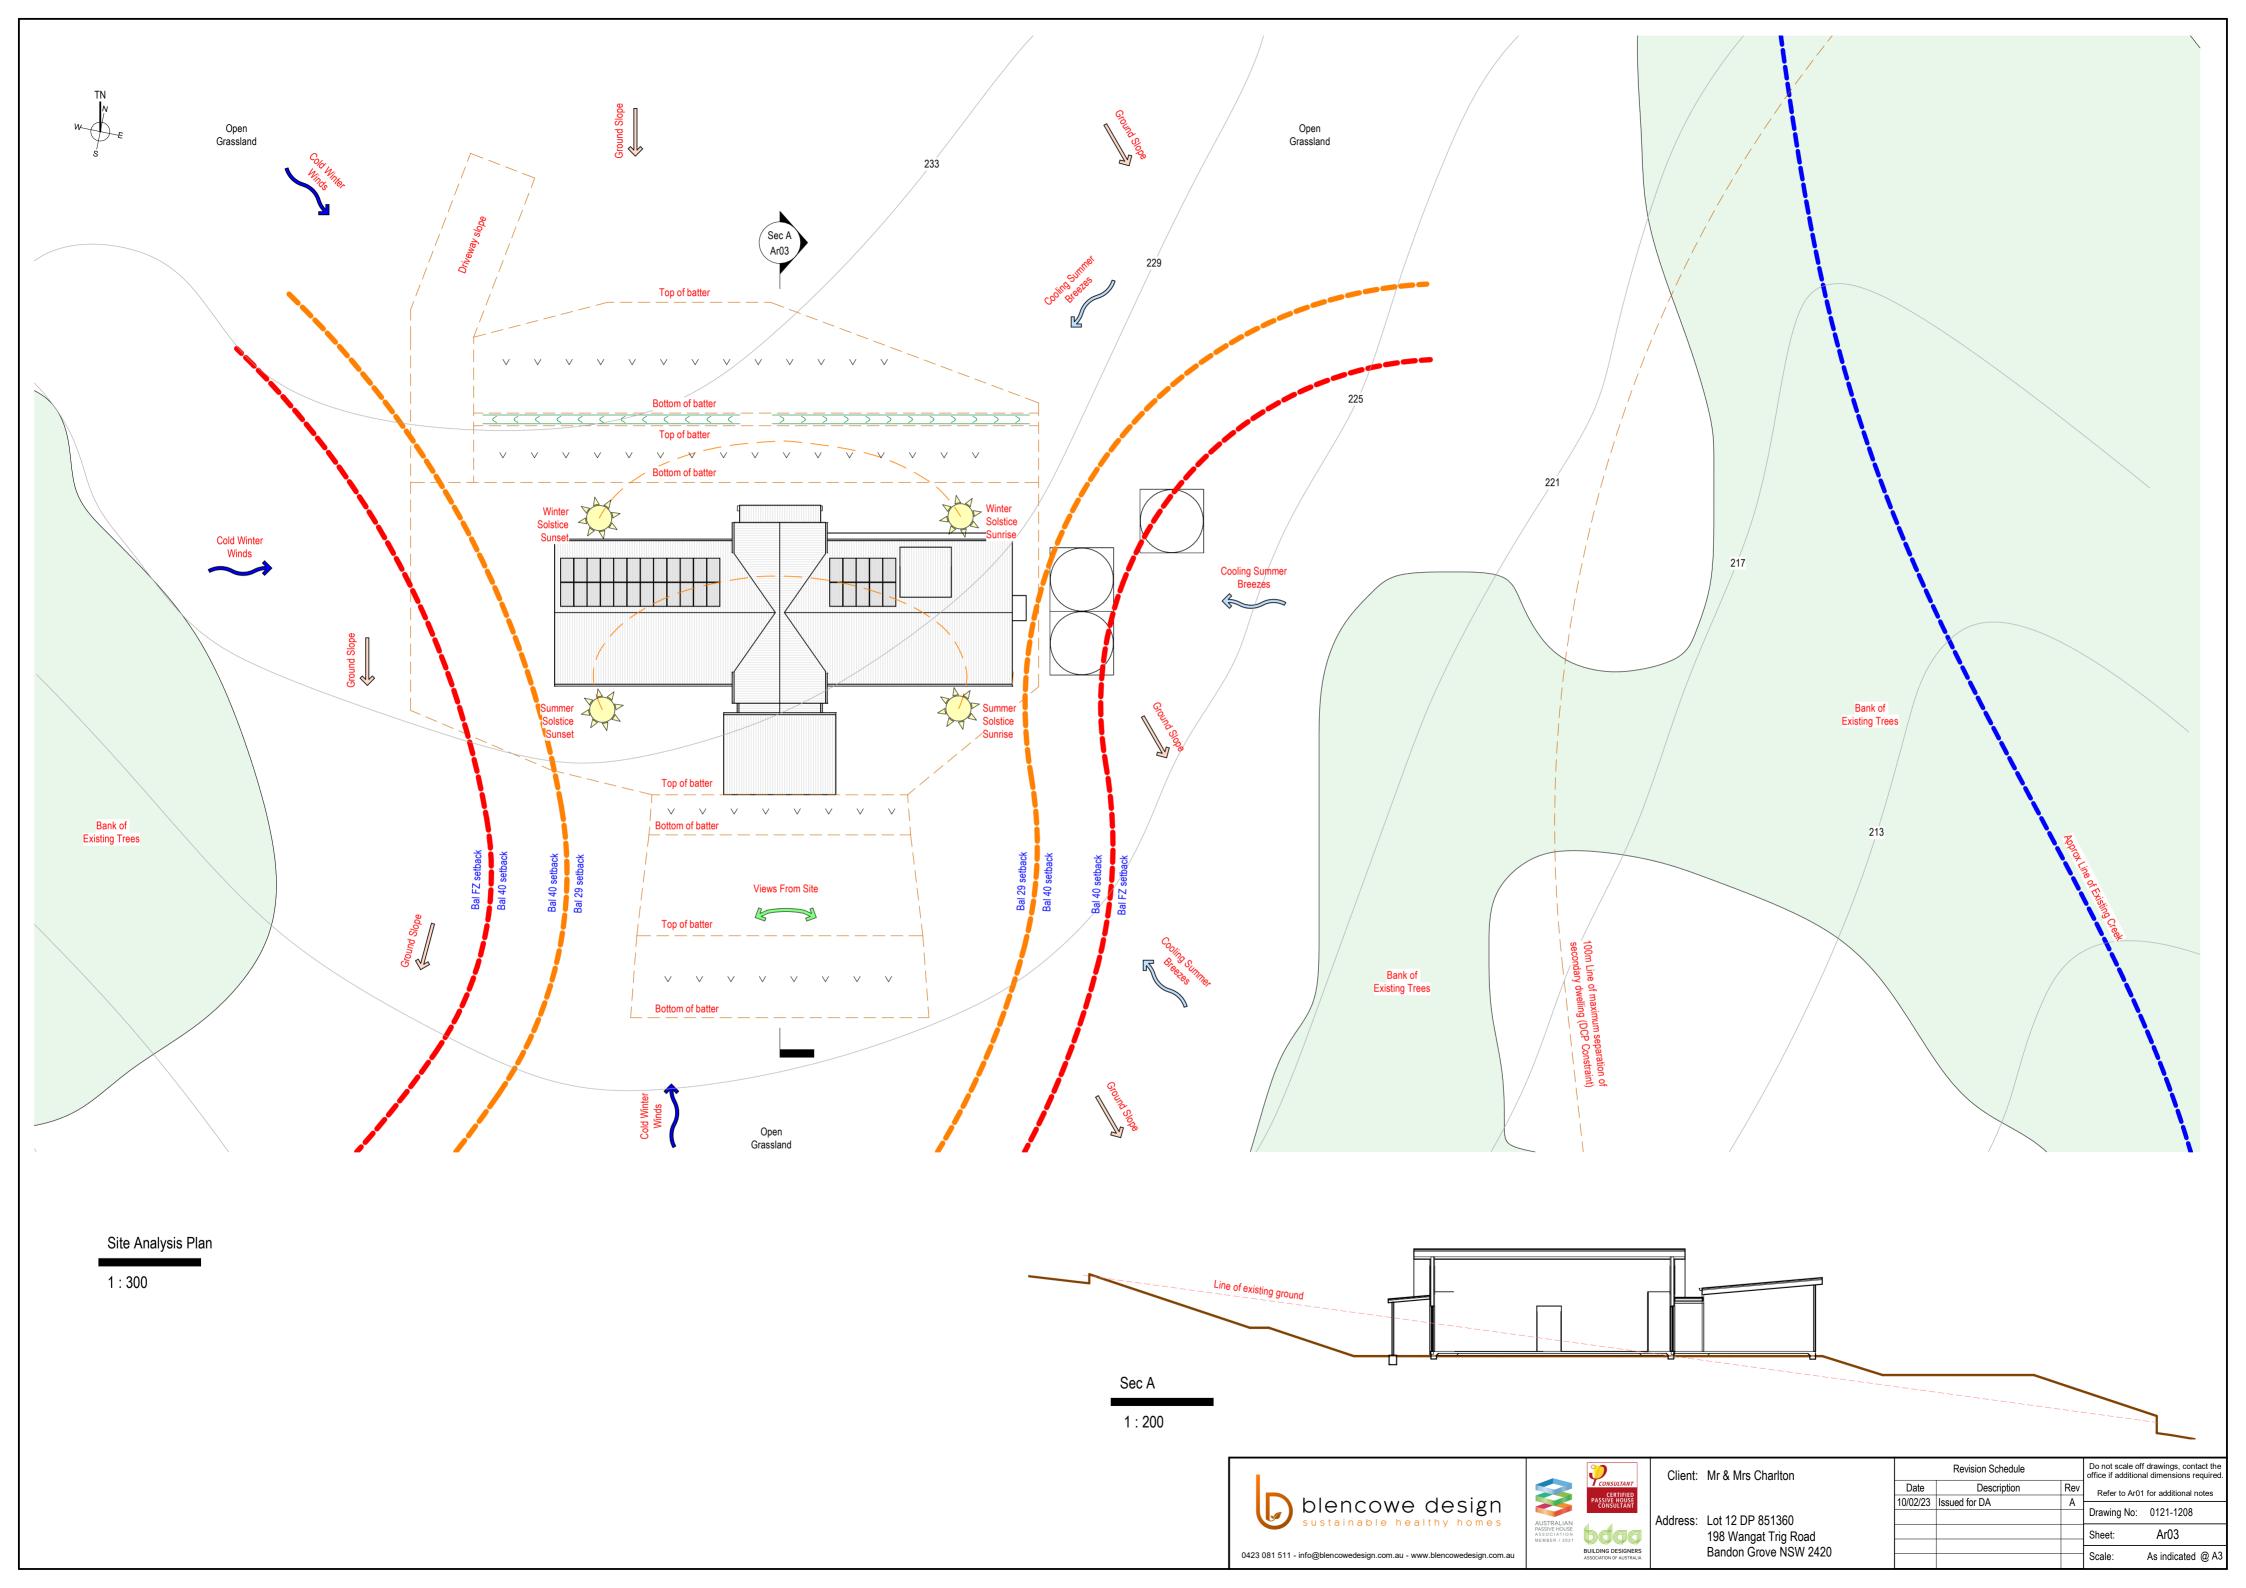


Basix, Sustainability and Construction Details

Detailed Project Specifications

		_											
Type Mark		Des	cription				Type Cor	nments				Additional deal	ils
Ceilings													
IPC	Internal P	lasterboard	ceiling							55mm Cove cornice			
Floors													
EGC			ing Concre	te		ip finish (roug							
IBJF		earer & jois				eboard floorin		or finish					
IGC	-		ng concrete)		th finish concr							
WAF	Wet area	floor			Sedov	vn concretet to	o wet area, til	e finish		Waterproofing to NCC	Part 3	.8.1	
Railings													
APS	Aluminiun	n privacy so	reen		Powde	ercoated finish	1						NCC Part 3.9.2 when hig
										than 1m from finished s	surface	9	
Roofs													
CSR	Colourbor	nd Superde	k Roofing					fixed to the manufac	turers				
CMD	Ctan din a					cations & the			4				
SMR	Standing	seam meta	TOOT			cations & the		fixed to the manufac	turers				
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						0	nd Elec	, Door Cala	dula				
						Grou	na Fioo	r Door Sche	<u>uule</u>				
Level	Mark	Heigh	t Wid	lth	Туре	Assembl	v	Frame Material		Room Name		(Comments
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Ground Floor	GD01	2040	820		Swing	0	UPVC /	Timber / Thermally b	roken Alu	Bag/Coat Nook	1	Air tight	
Ground Floor	GD01	2134	820		Square set	-	0. 107			Living	- /		
Ground Floor	GD02	2134	820		Square set	-				Pantry			
Ground Floor	GD04	2400	1300		Square set	-				Living			
Ground Floor	GD05	2550	4920		Cavity slider	0				Lounge	ŀ	Hidden sliding w	/all
Ground Floor	GD06	2040	820		Swing	0				Laundry		nadori silaling vi	ruii
Ground Floor	GD07	2040	820		Swing	0				WC	\rightarrow		
Ground Floor	GD08	2040	2160		Sliding	000				Store	3	3/720 Leaf	
Ground Floor	GD09	2040	820		Swing	0				Bathroom		7720 2001	
Ground Floor	GD10	2040	820		Swing	0				Bed 4 / Office	_		
Ground Floor	GD11	2040	2460		Sliding	000				Bed 4 / Office	1	3/820 Leaf	
Ground Floor	GD12	2040	820		Swing	0				Main Suite	-	7020 LGai	
Ground Floor	GD12	2134	820		Square set					WIR	\rightarrow		
Ground Floor	GD13	2040	1760		Cavity slider	0				Ensuite	\rightarrow		
Ground Floor	GD14	2040	820		Swing	0				Bed 2	\rightarrow		
Ground Floor	GD15	2040	2760		Sliding	000				Bed 2	-	2/020 Loof	
	GD17	2040	820			0				Bed 3	- 13	3/920 Leaf	
Ground Floor Ground Floor	GD17 GD18	2040	2760		Swing Sliding	000				Bed 3		3/920 Leaf	
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Ground Floor	GW04	1200	1800	Tilt 7	Turn	00	950	Bed 4 / Office		imber / Thermally	Dou	ble	
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									broken A	lu.			
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									broken A	lu.			
0	OMOZ	1200	1800	Tilt 7	Turn	00	950	Bed 3		imber / Thermally	Dou	ble	
Ground Floor	GW07					_	0.50		broken A	lu.			
		1500	000		Lurn	0	650	WIR			-		
Ground Floor	GW08	1500	900	Tilt 7			500	Hallway	UPVC / 1	Timber / Thermally	Dou	ble	
Ground Floor		1500 600	900 1250	Tilt 7		0							
Ground Floor Raised FCL	GW08 HW01	600	1250	Tilt			500	I I all	broken A	lu.			
Ground Floor Raised FCL	GW08			_		0	500	Hallway	UPVC / 1	lu. Timber / Thermally	Dou		
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Window/skylight in Kitchen

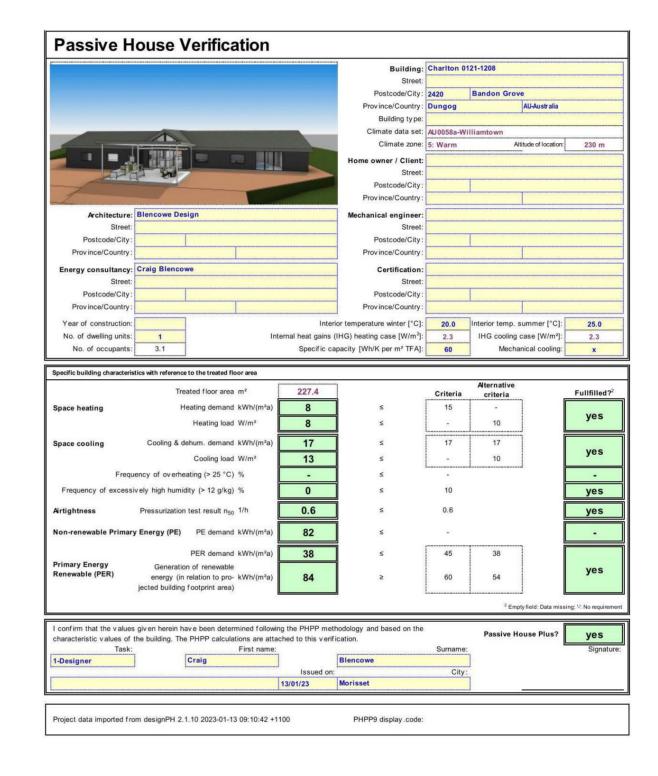Number of bedrooms

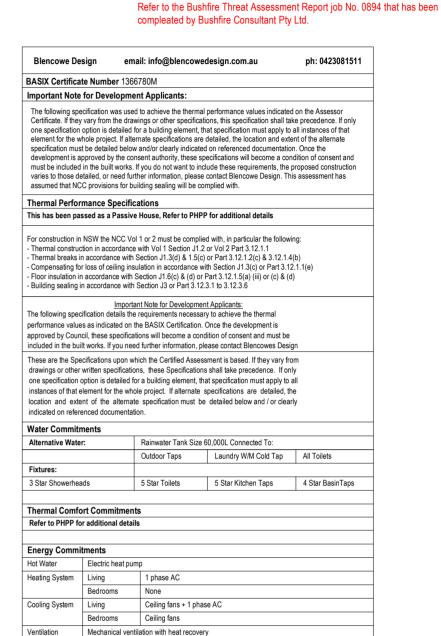All bathrooms/toilet

Laundry

Window/skylight in Bathrooms/Toilets

"Well ventilated" fridge space

equivilant.) Ensure continuity of wall to roof Weathe

roofing batten (min 35mm)

Natural Lighting

Other Commitments Outdoor clothes line

Bushfire Construction Notes All construction to be built to:

BAL-29 (AS3959-2009 Section 7)

• Subfloor supports complying with AS3959-2009 Section 7.2 • Floors complying with AS3959-2009 Section 7.3 External Walls complying with AS3959-2009 Section 7.4


Roofs complying with AS3959-2009 Section 7.6

• External Glazed Elements complying with AS3959-2009 Section 7.5

Water & gas supply pipes complying with AS3959-2009 Section 7.8

Note: All construction to comply with AS3959-2018 and planning for bushfire protection 2019. Refer to bushfire notes in this drawing set for Excerpt from AS3959. Please refer to the Australian Standard for further details.

• Verandahs, decks, steps, ramps & landings complying with AS3959-2009

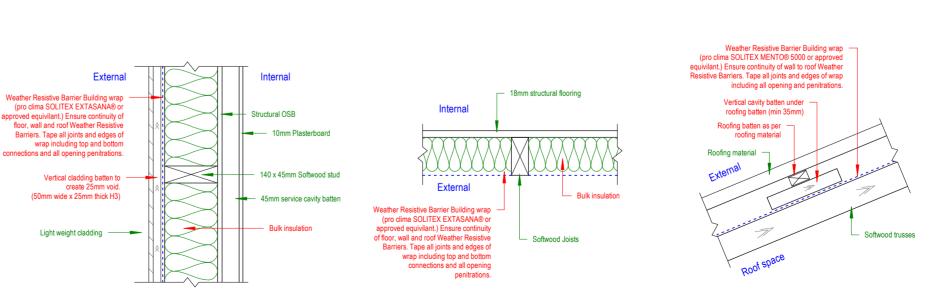

Typical Light Weight Clad Insulation Detail

Typical Framed Floor Insulation Detail

Typical Truss (top) Insulation Detail

Typical Skillion Roof Insulation Detail

4 Dedicated

Yes Dedicated

Yes Dedicated

Yes Dedicated

Yes Dedicated

No










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North Elevation

1:100

All construction to be built to:

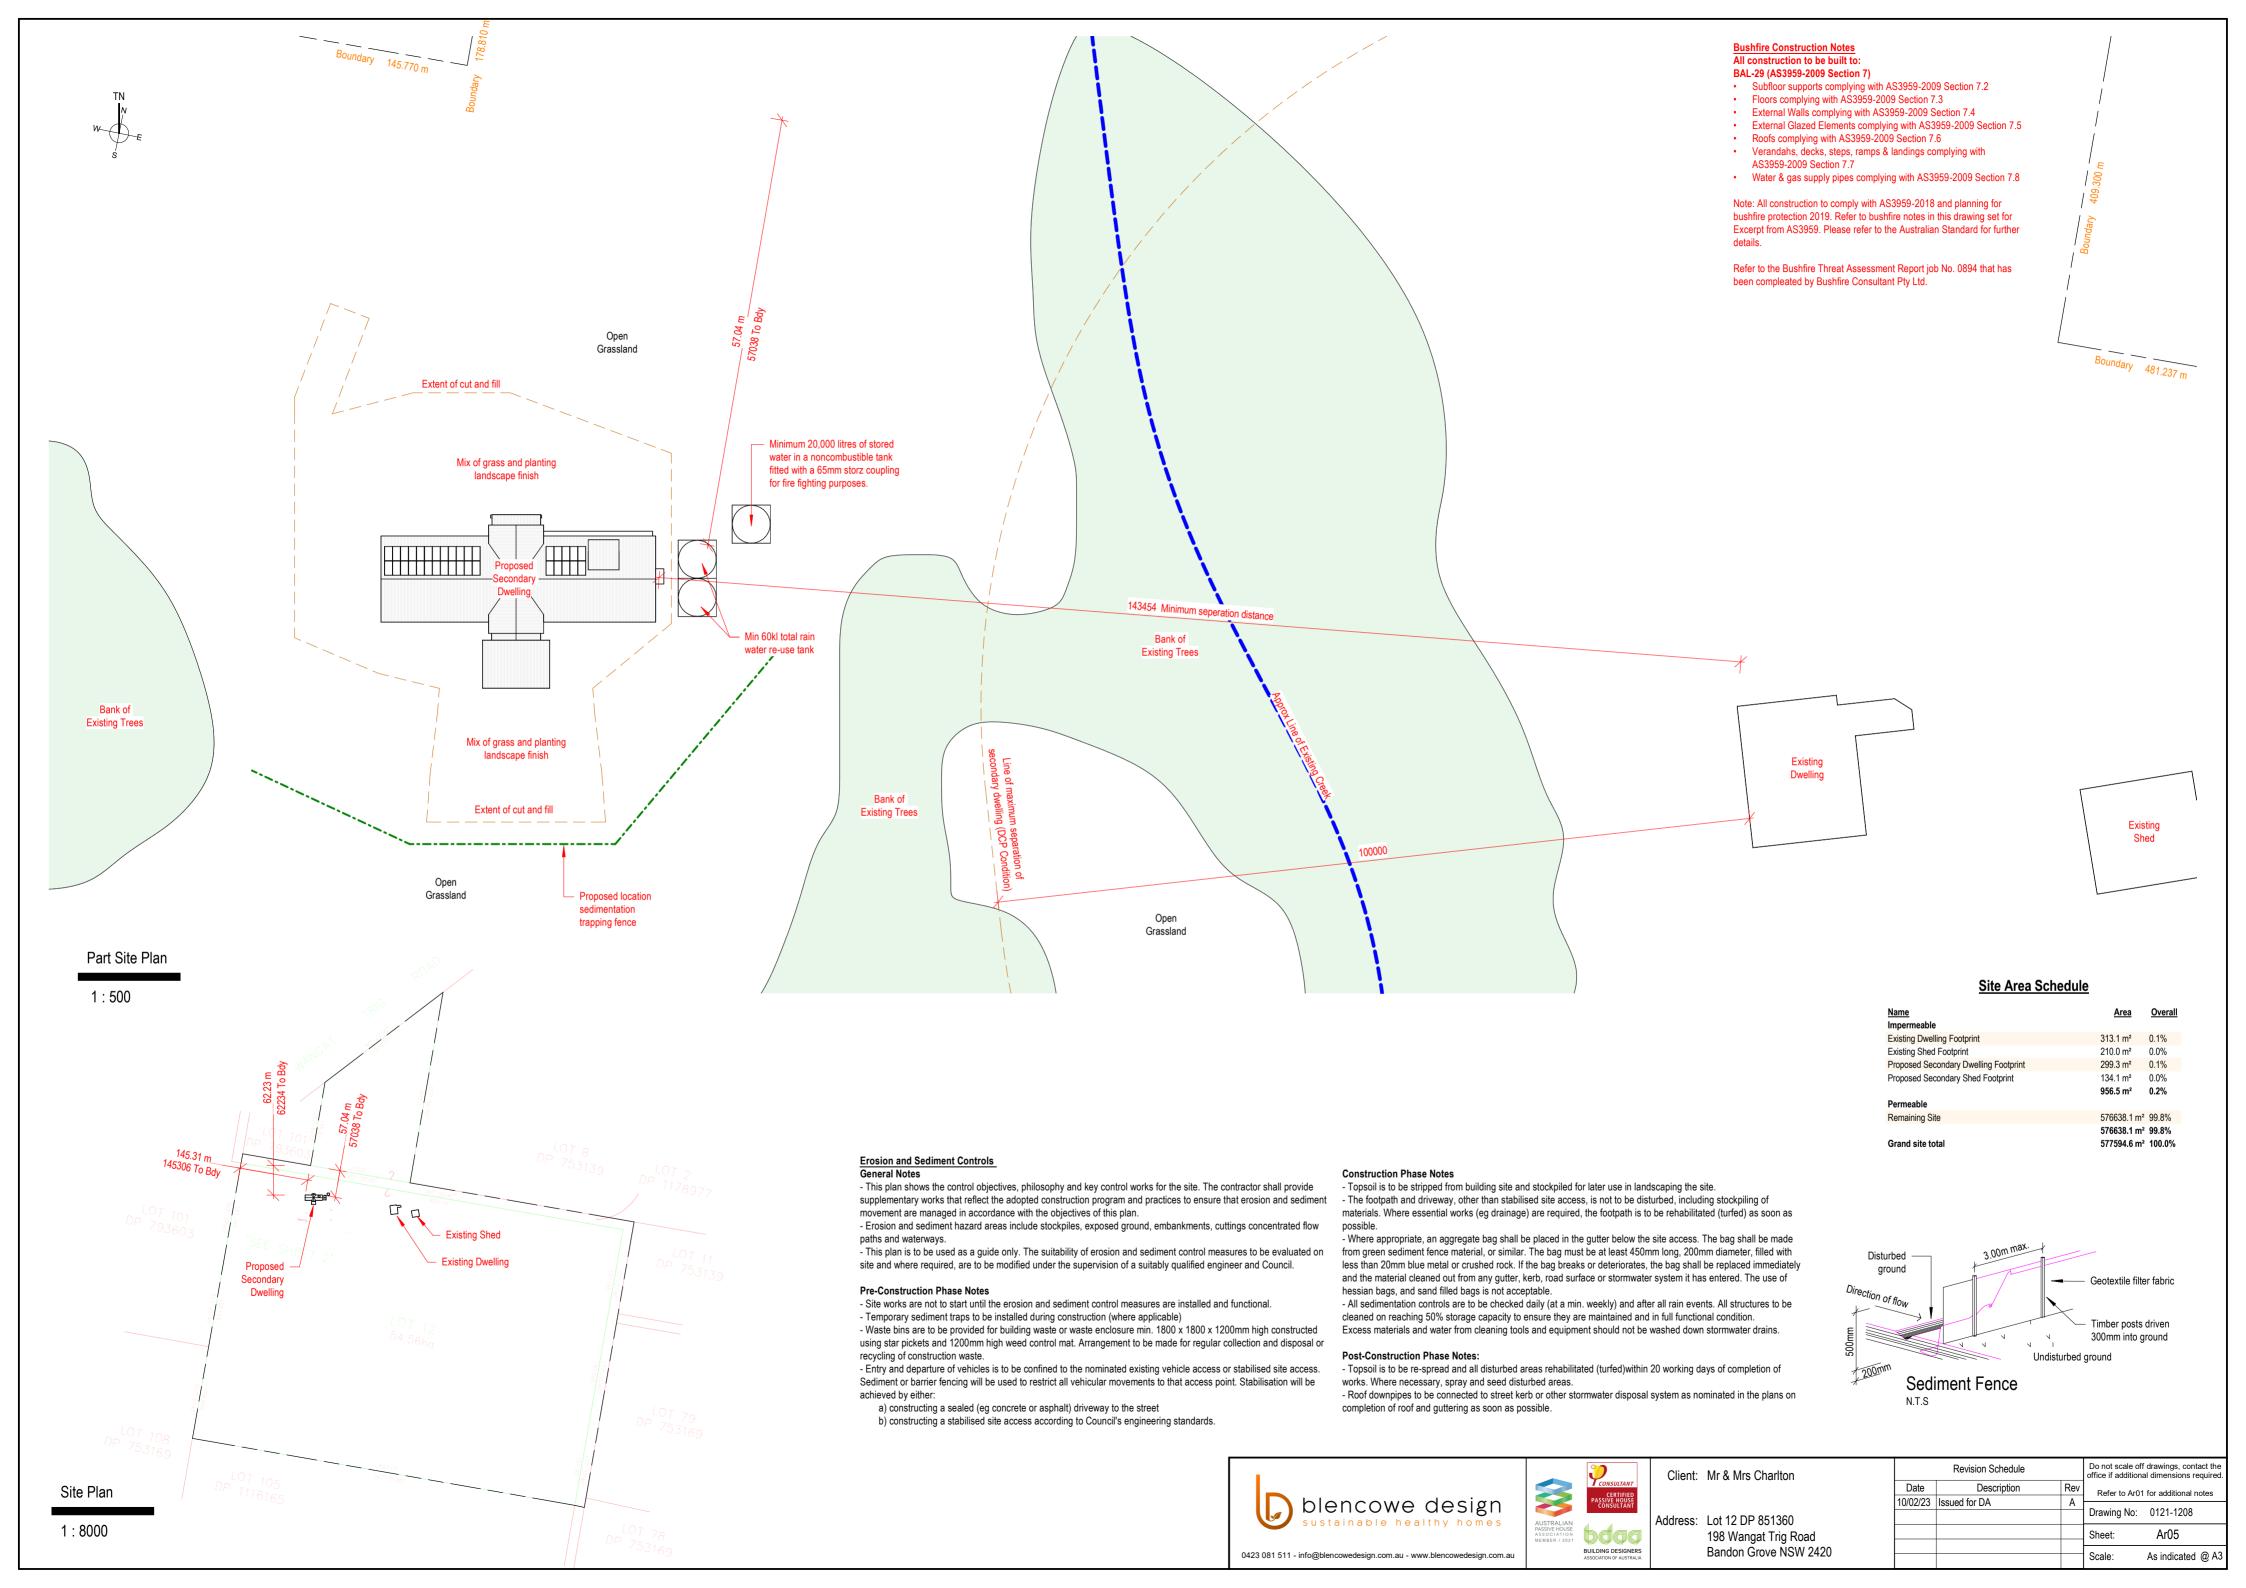BAL-29 (AS3959-2009 Section 7)

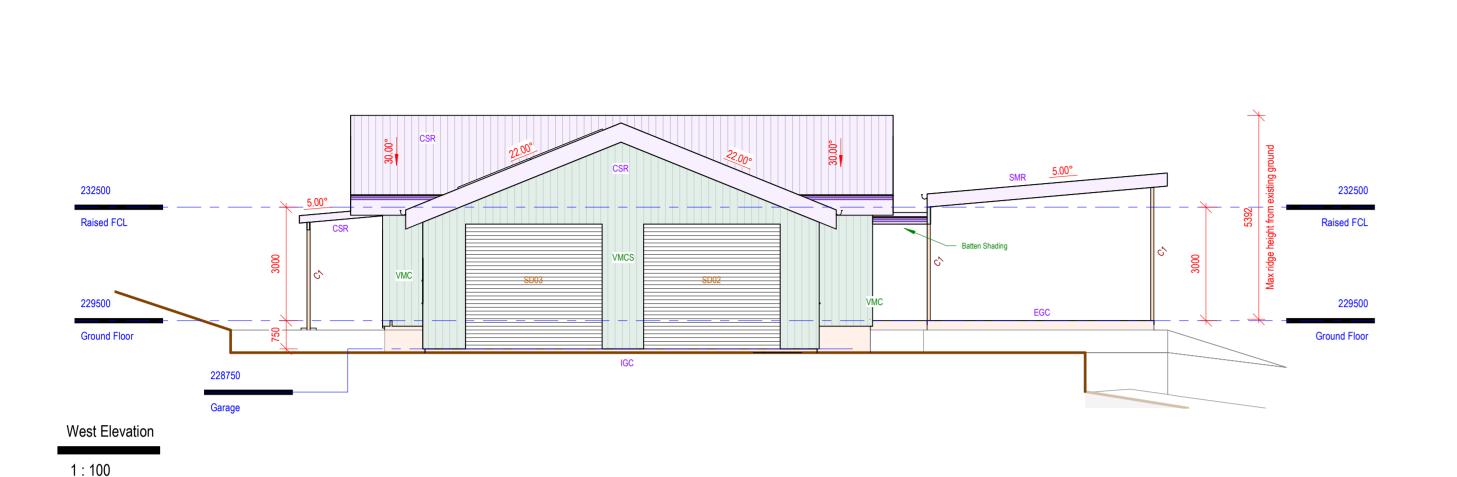- Subfloor supports complying with AS3959-2009 Section 7.2
 Floors complying with AS3959-2009 Section 7.3
 External Walls complying with AS3959-2009 Section 7.4
 External Glazed Elements complying with AS3959-2009 Section 7.5
 Roofs complying with AS3959-2009 Section 7.6
 Verandahs, decks, steps, ramps & landings complying with AS3959-2009 Section 7.7

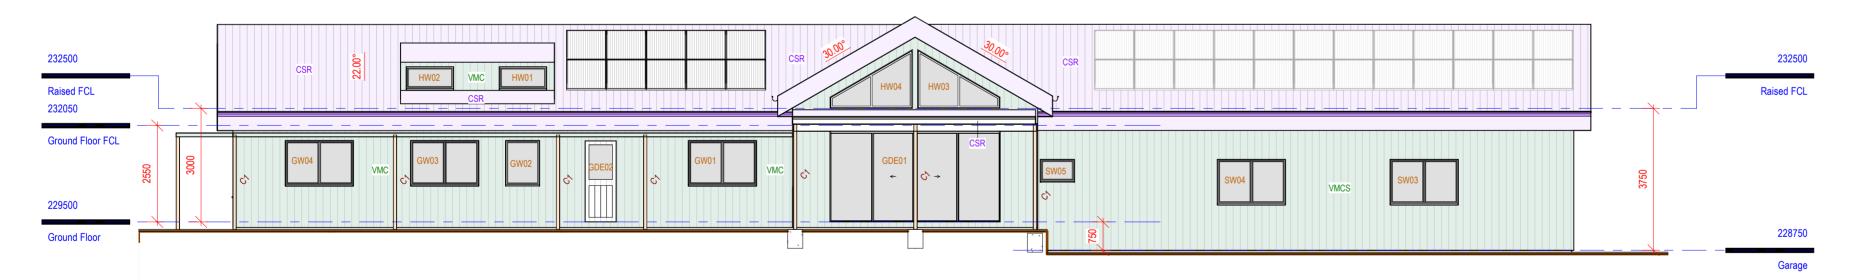Tag Mark Key

Colourbond Superdek Roofing SMR Standing seam metal roof Stairs

ETS Enclosed timber stairs

IPC Internal Plasterboard ceiling Floors
EGC Exterior Ground Bearing Concrete IBJF Internal bearer & joist IGC Internal ground bearing concrete

WAF Wet area floor Railings

APS

Aluminium privacy screen

Type Mark

Roofs

Walls

Structural Columns C1 Steel column

DTS Double timber stud

SSW Shed seperation wall
TS Timber stud

FGSS Frameless glass shower screen

VMC Colourbond Superdek vertical

cladding
VMCS Colourbond Superdek vertical cladding

- AS3959-2009 Section 7.7
- Water & gas supply pipes complying with AS3959-2009 Section 7.8

Note: All construction to comply with AS3959-2018 and planning for bushfire protection 2019. Refer to bushfire notes in this drawing set for

Excerpt from AS3959. Please refer to the Australian Standard for further

Refer to the Bushfire Threat Assessment Report job No. 0894 that has been compleated by Bushfire Consultant Pty Ltd.








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South Elevation

1:100

All construction to be built to:

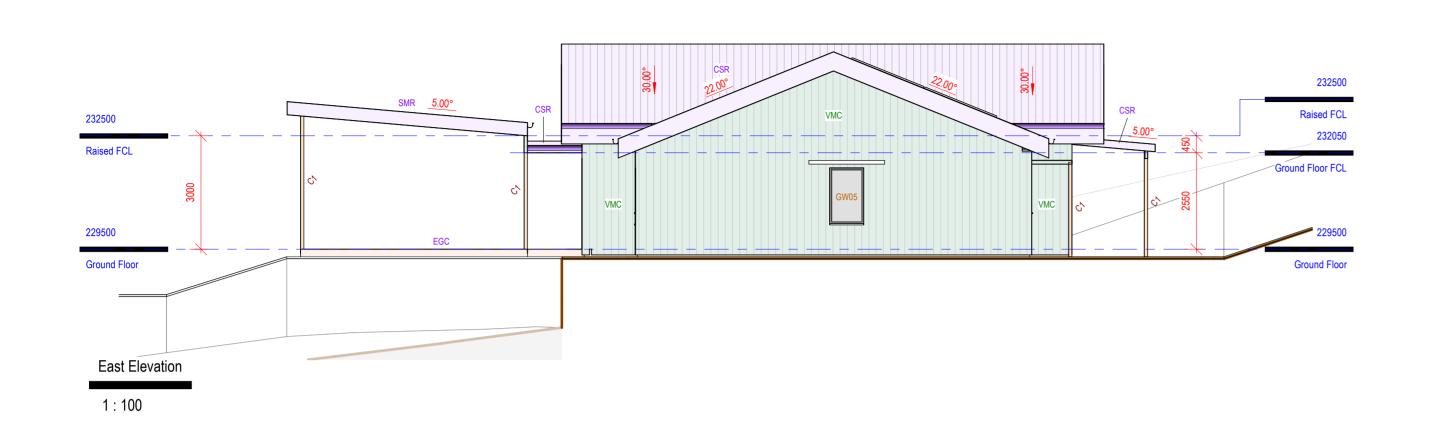BAL-29 (AS3959-2009 Section 7)

- BAL-29 (AS3959-2009 Section 7)
 Subfloor supports complying with AS3959-2009 Section 7.2
 Floors complying with AS3959-2009 Section 7.3
 External Walls complying with AS3959-2009 Section 7.4
 External Glazed Elements complying with AS3959-2009 Section 7.5
 Roofs complying with AS3959-2009 Section 7.6
 Verandahs, decks, steps, ramps & landings complying with AS3959-2009 Section 7.7

- AS3959-2009 Section 7.7
- Water & gas supply pipes complying with AS3959-2009 Section 7.8

Tag Mark Key

Internal Plasterboard ceiling Floors
EGC Exterior Ground Bearing Concrete

Internal ground bearing concrete

Aluminium privacy screen

Standing seam metal roof

Colourbond Superdek Roofing

IBJF Internal bearer & joist IGC Internal ground bearing

WAF Wet area floor

Stairs

ETS Enclosed timber stairs

DTS Double timber stud

FGSS Frameless glass shower screen SSW Shed seperation wall TS Timber stud

VMC Colourbond Superdek vertical cladding
VMCS Colourbond Superdek vertical cladding

Type Mark

Railings APS

Roofs

Walls

SMR

Structural Columns C1 Steel column

Note: All construction to comply with AS3959-2018 and planning for bushfire protection 2019. Refer to bushfire notes in this drawing set for Excerpt from AS3959. Please refer to the Australian Standard for further

Refer to the Bushfire Threat Assessment Report job No. 0894 that has been compleated by Bushfire Consultant Pty Ltd.









Client: Mr & Mrs Charlton Address: Lot 12 DP 851360


198 Wangat Trig Road Bandon Grove NSW 2420


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Date	Description	Rev	Refer to Ar01 for additional note			
10/02/23	Issued for DA	Α	Drawing No: 0121-1208			
			Drawing No:	0121-1208		
			Sheet:	Ar08		
			Scale:	1:100 @ A3		

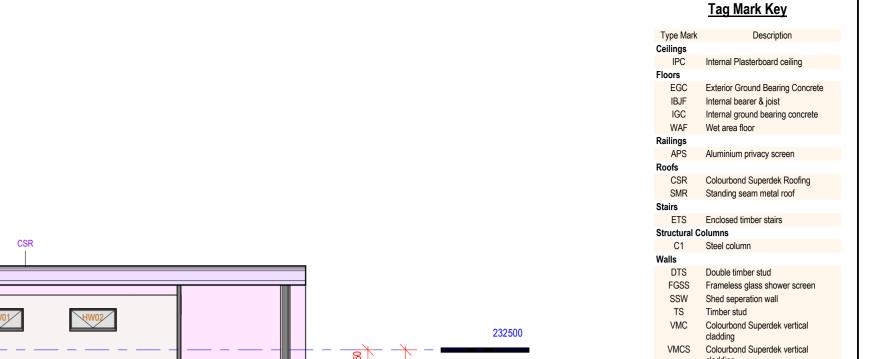

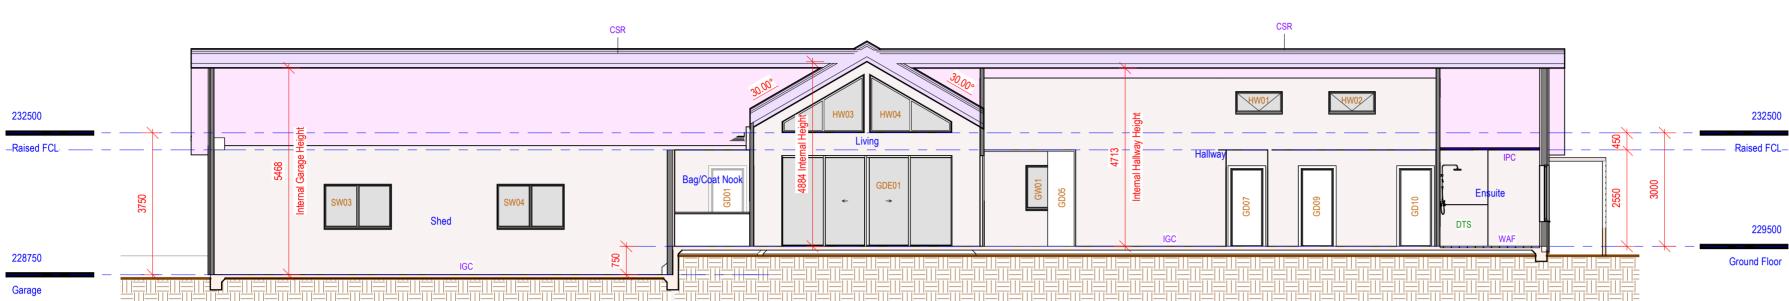

Sec 1 1:100

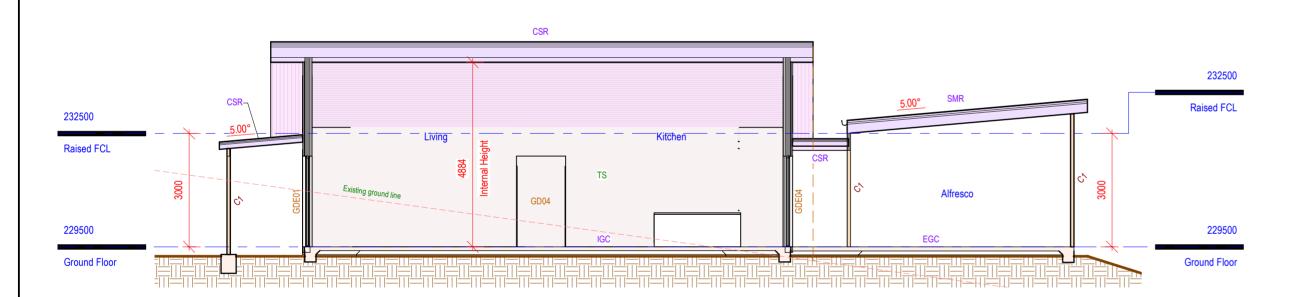

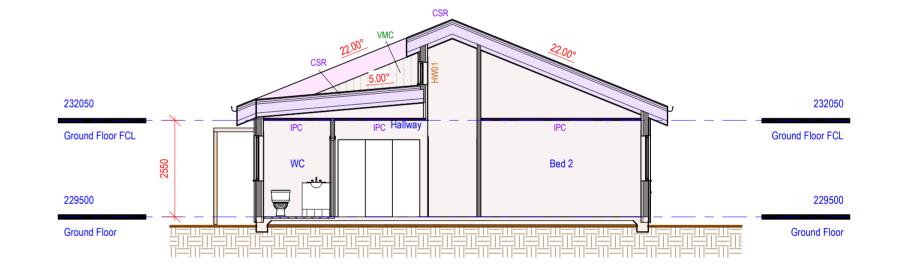

Sec 2 1:100

1:100

Revision Schedule

All construction to be built to: BAL-29 (AS3959-2009 Section 7)

- BAL-29 (AS3959-2009 Section 7)
 Subfloor supports complying with AS3959-2009 Section 7.2
 Floors complying with AS3959-2009 Section 7.3
 External Walls complying with AS3959-2009 Section 7.4
 External Glazed Elements complying with AS3959-2009 Section 7.5
 Roofs complying with AS3959-2009 Section 7.6
 Verandahs, decks, steps, ramps & landings complying with AS3959-2009 Section 7.7

- AS3959-2009 Section 7.7

cladding

Water & gas supply pipes complying with AS3959-2009 Section 7.8

Note: All construction to comply with AS3959-2018 and planning for bushfire protection 2019. Refer to bushfire notes in this drawing set for Excerpt from AS3959. Please refer to the Australian Standard for further

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Description 10/02/23 Issued for DA 198 Wangat Trig Road Bandon Grove NSW 2420


		f drawings, contact the al dimensions required.			
Rev	Refer to Ar01 for additional notes				
Α	Drawing No:	0121-1208			
	Sheet:	Ar09			
	Scale:	1:100 @ A3			



North West 3D View



South East 3D View

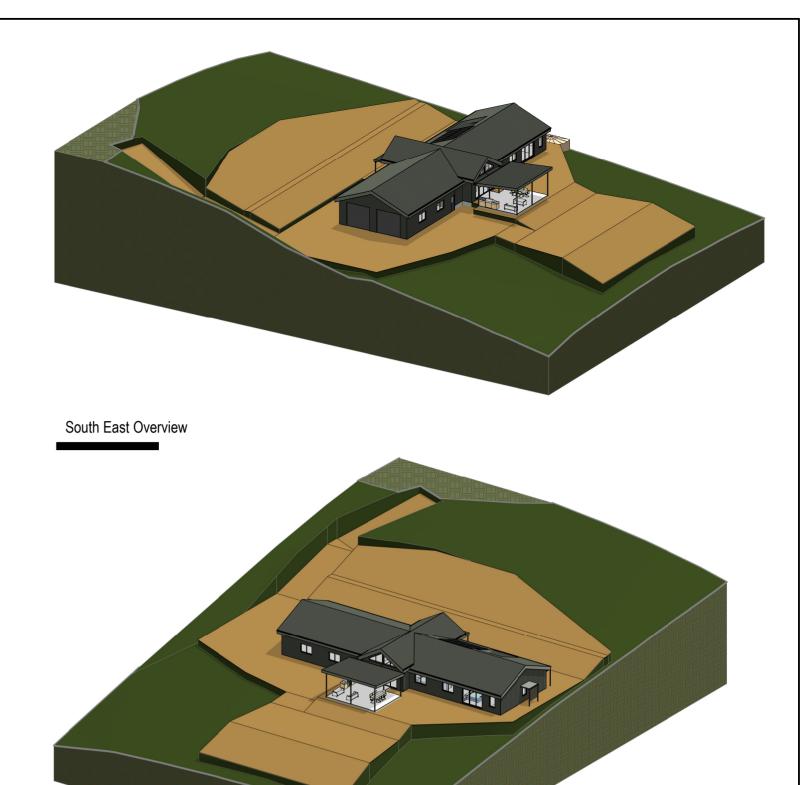

South West Overview









Client: Mr & Mrs Charlton


Address: Lot 12 DP 851360 198 Wangat Trig Road Bandon Grove NSW 2420


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Date	Description	Rev	Refer to Ar01	01 for additional notes		
0/02/23	Issued for DA	Α	-			
			Drawing No:	0121-1208		
			Sheet:	Ar10		
			Scale:		@ A3	

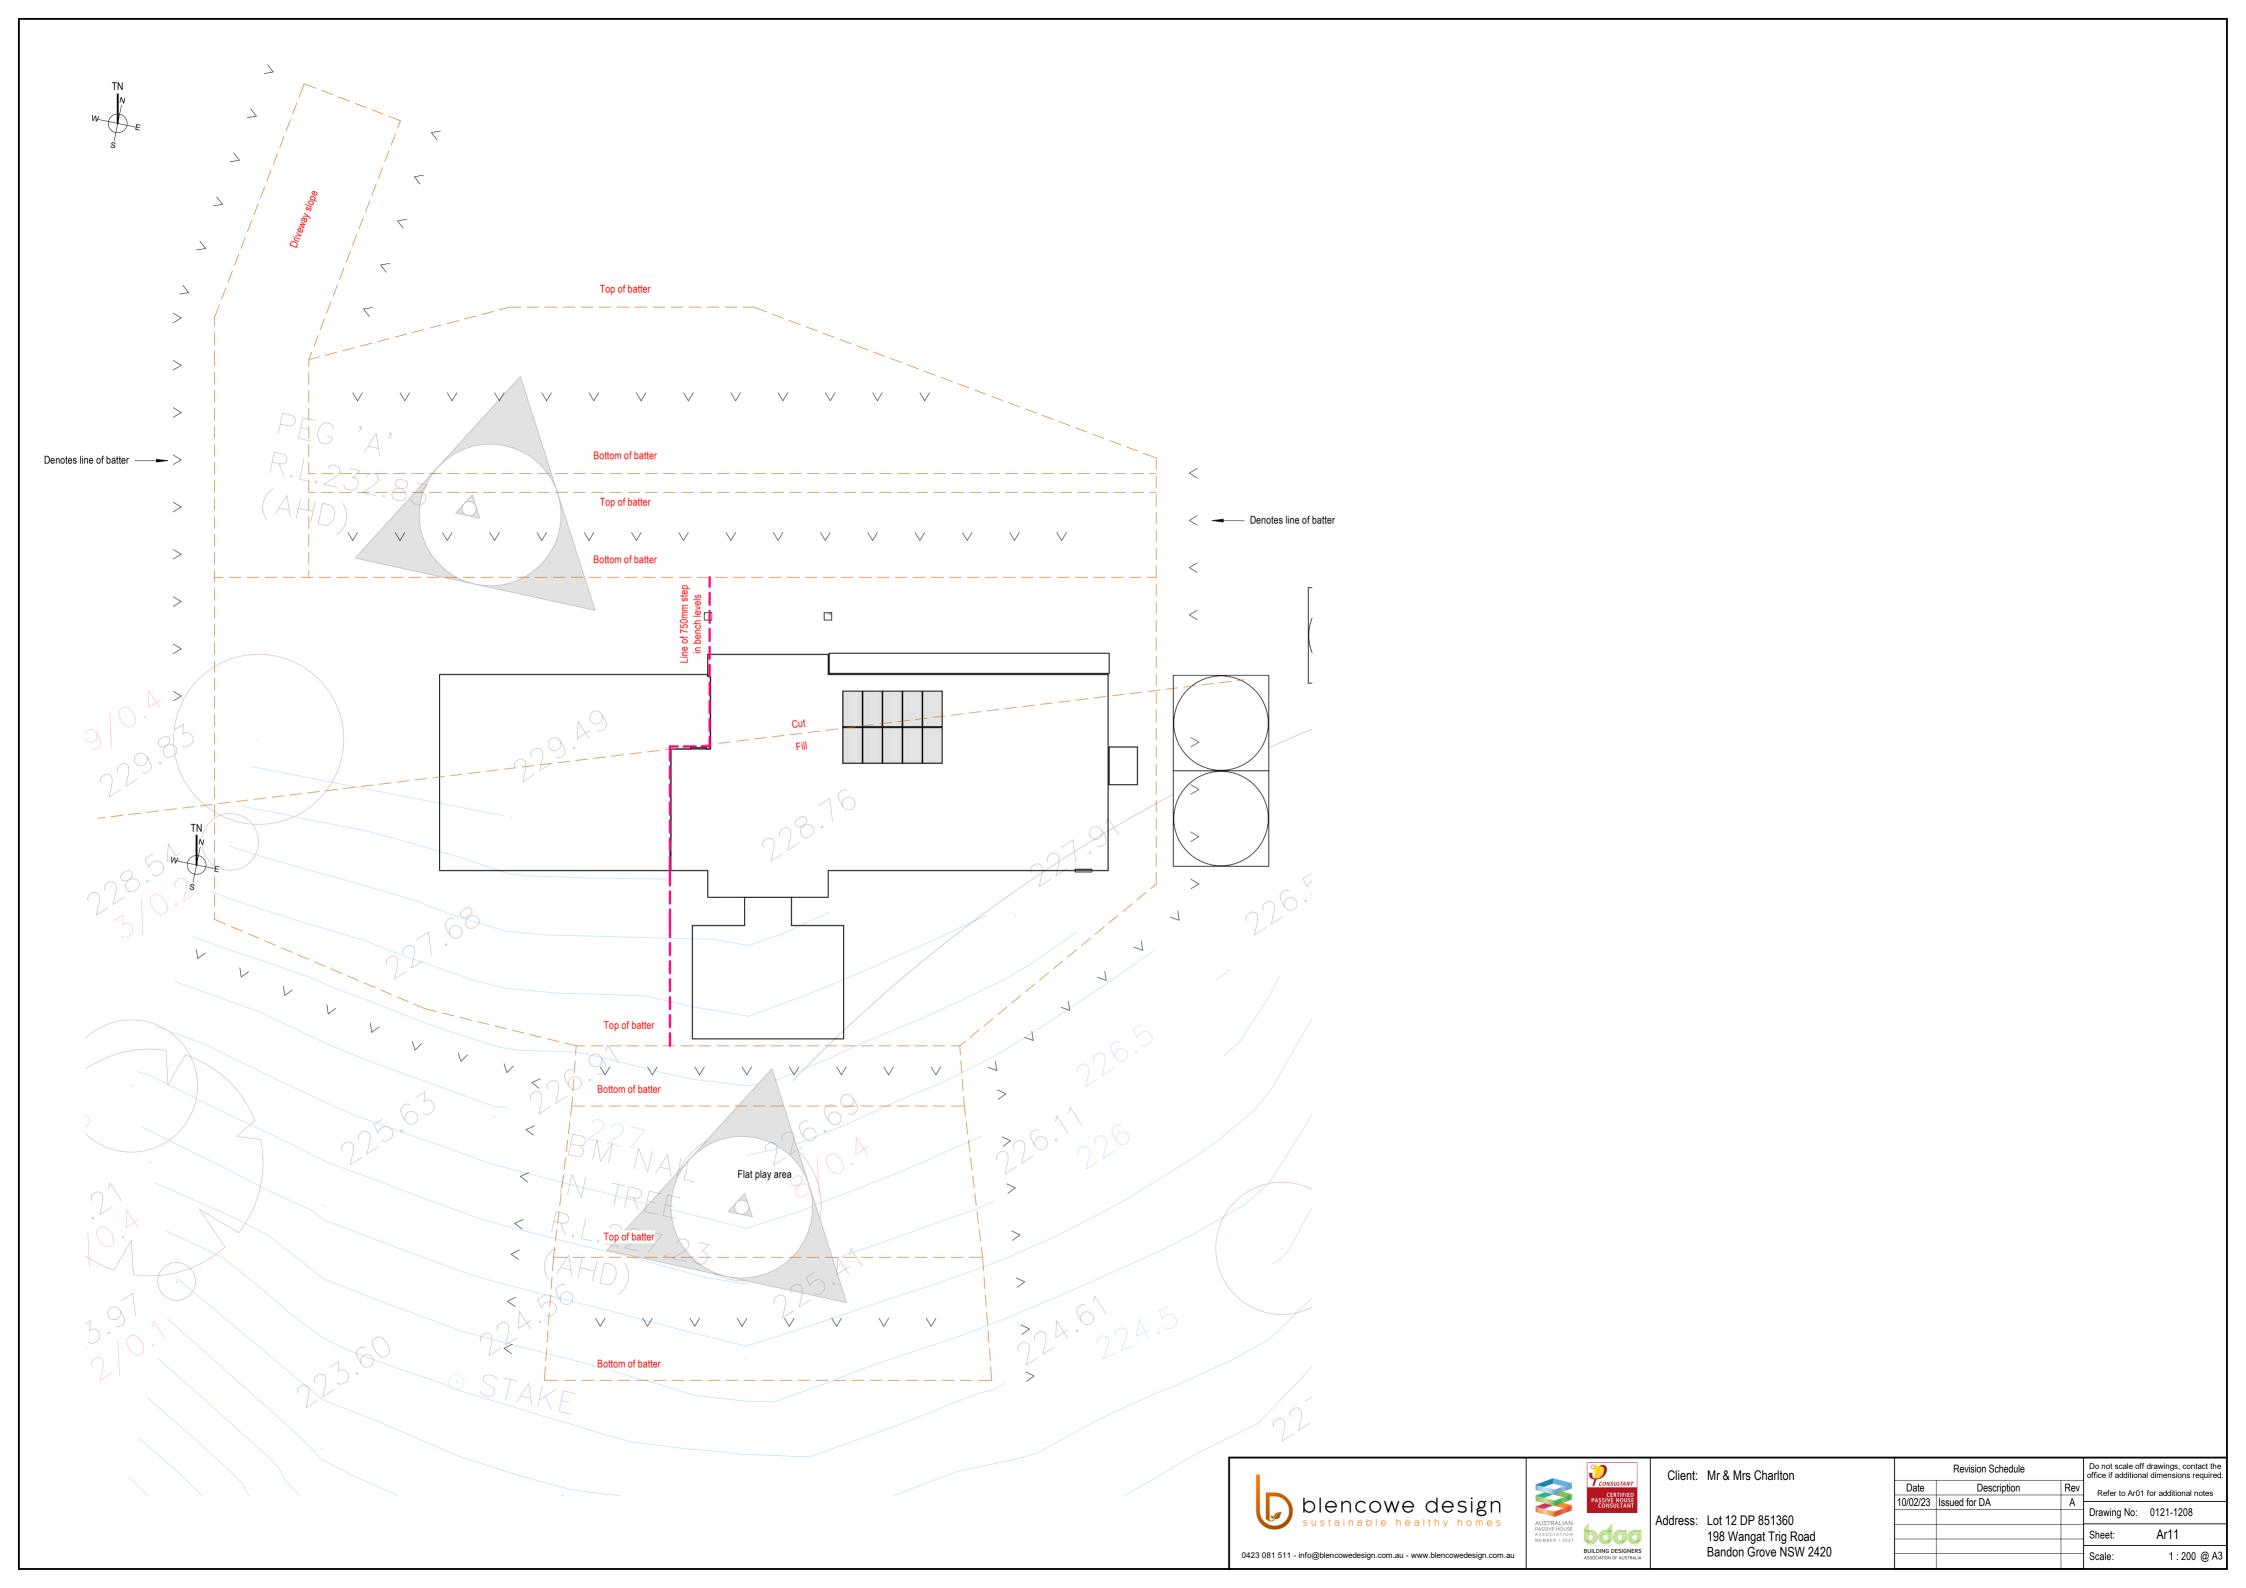

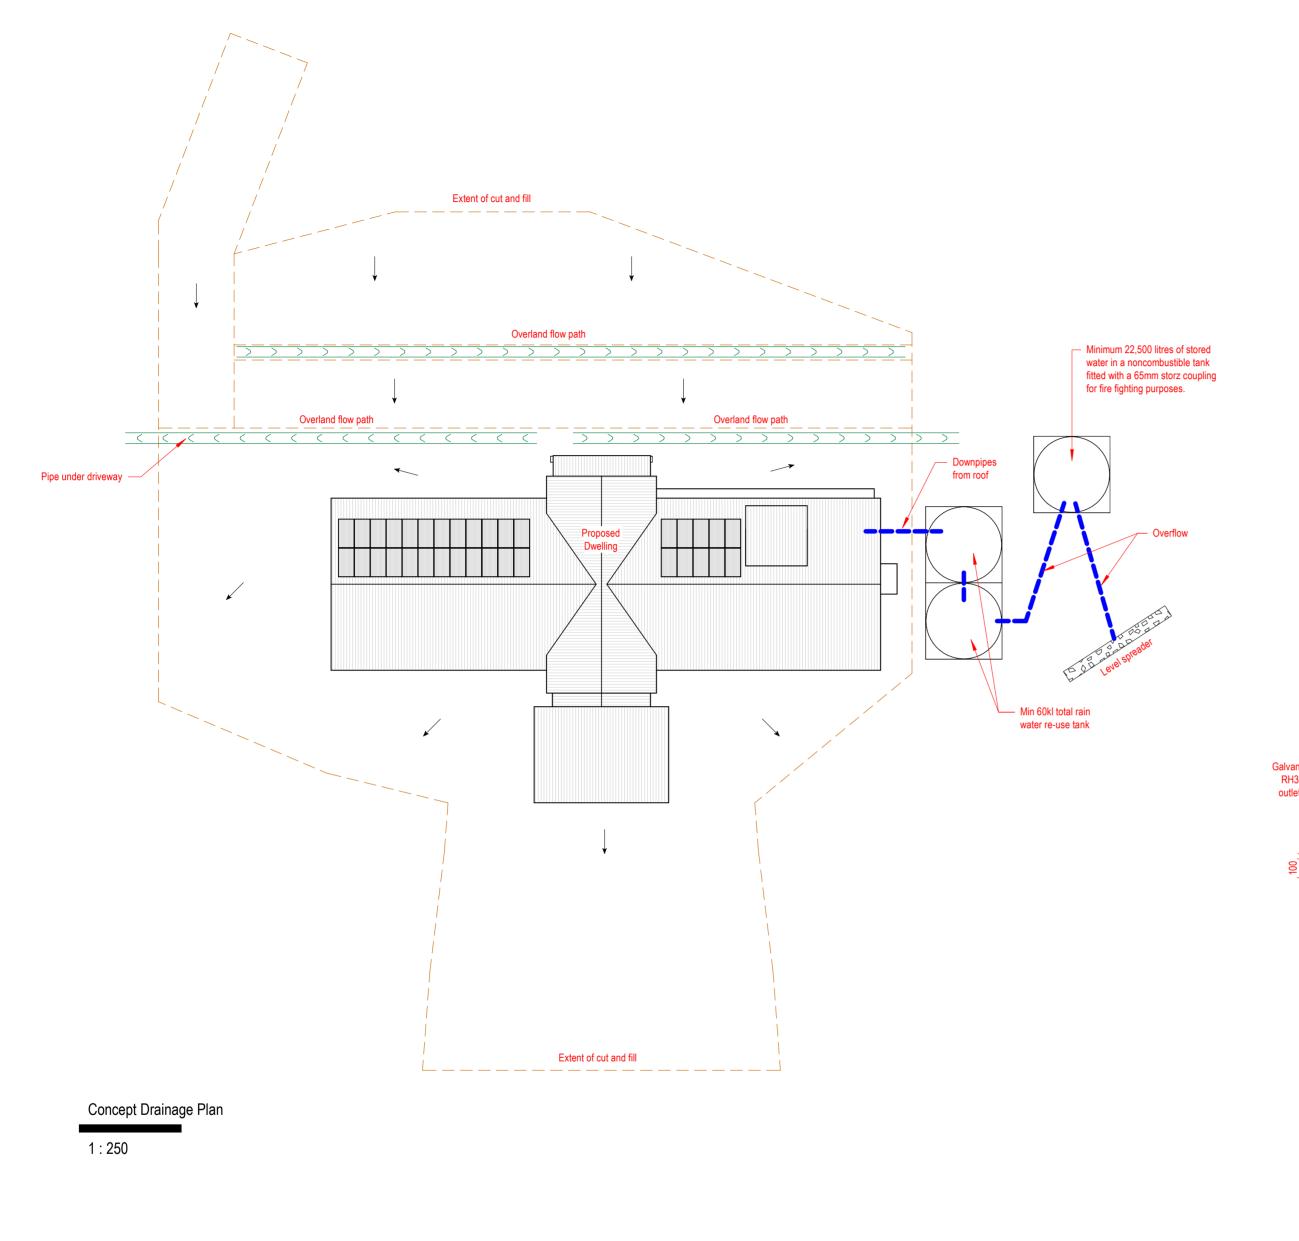

This length of the site works to be 50mm below the top of the remaining grassed slope to create level spreader

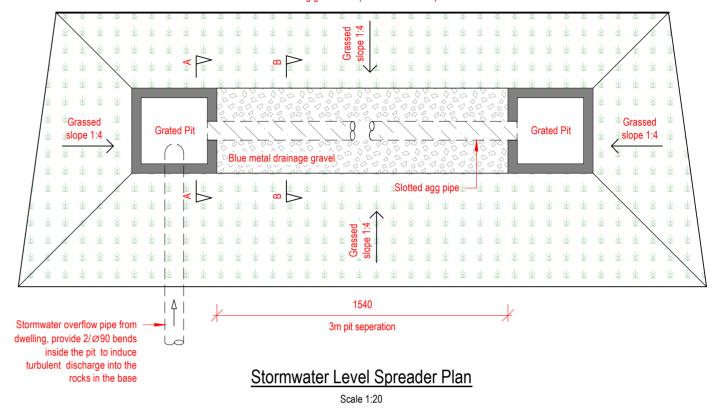

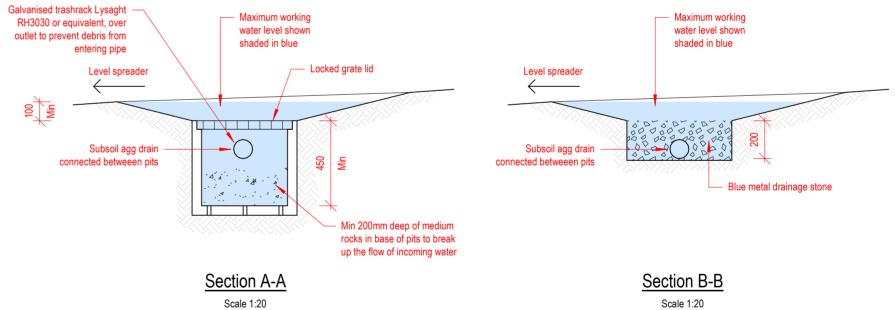

All construction to be built to: BAL-29 (AS3959-2009 Section 7)

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Client: Mr & Mrs Charlton

Address: Lot 12 DP 851360

Date 10/02/23 Issued for DA 198 Wangat Trig Road Bandon Grove NSW 2420

Do not scale off drawings, contact the office if additional dimensions required. Revision Schedule Description Refer to Ar01 for additional notes Drawing No: 0121-1208 Scale: As indicated @ A3